# GENERAL NOTES

- 1. ALL APPLICABLE CONSTRUCTION SHALL CONFORM TO THE VIRGINIA UNIFORM STATEWIDE BUILDING CODE (U.S.B.C.) ,2015 BASED UPON INTERNATIONAL RESIDENTIAL CODE (I.R.C.) .2015
- 2. CODES GOVERN OVER DRAWING PLANS, VERIFY ALL LOCAL CODES AND SPECIFICATIONS.
- 3. PRIOR TO THE BEGINNING OF ANY WORK, THE CONTRACTOR SHALL OBTAIN AND PAY FOR ALL BUILDING PERMITS FOR THE CONSTRUCTION OF THIS PROJECT AS REQUIRED BY THE BUILDING INSPECTION DEPARTMENT OF THE COUNTY OR CITY THE PROJECT IS LOCATED IN.
- 4. BUILDING PERMITS SHALL BE PROMPTLY AND CONSPICUOUSLY POSTED AT THE BUILDING SITE AT ALL TIMES DURING
- 5. PRIOR TO COMMENCING CONSTRUCTION (ORDERING MATERIALS, ETC.) THE PERMIT CONTRACTOR IS OBLIGATED TO REPORT ANY PLAN INCONSISTENCY TO THE DESIGNER/ARCHITECT, INCLUDING DIMENSIONAL INACCURACY, SPECIFICATION CONFLICT, CODE AMBIGUITY, AND/OR STRUCTURAL INADEQUACY. FAILURE TO REPORT ANY SUCH ISSUE, IN WRITING, WAVES ANY LIABILITY FOR RESOLUTION/ACTION ON THE PART OF THE DESIGNER/ARCHITECT. 31. ALL TUB/SHOWER ENCLOSURES TO BE WATER RESISTANT UP TO 6' TYP.
- 6. ALL LUMBER USED THROUGHOUT TO BE MINIMUM No.2 STRUCTURAL GRADE
- ALL WOOD TRUSSES, T.J.I.'s & ENGINEERED LUMBER SHALL BE CERTIFIED BY THE MANUFACTURER. TRUSSES AND FRAMING MEMBERS SHALL HAVE A CAPABILITY TO SUPPORT LIVE AND DEAD LOADS AS SPECIFIED BY ALL APPLICABLE CODES, AND/OR AS FOLLOWS:

DESIGN LOAD	LIVE LOAD	DEAD LOAD
CEILING JOIST	20 P.S.F.	10 P.S.F.
LIVING AREAS	40 P.S.F.	10 P.S.F.
SLEEPING AREAS	30 P.S.F.	10 P.S.F.
ROOF AREAS	20 P.S.F.	10 P.S.F.
ATTIC AREA LTD. STORAGE	20 P.S.F.	10 P.S.F.

- 7. ALL CONCRETE FOOTINGS SHALL BEAR ON UNDISTURBED SOIL BELOW LOCAL FROST LINES AS PER ALL LOCAL BUILDING
- 8. ALL CONCRETE SHALL BE A MINIMUM OF 3,000 P.S.I. FOR INTERIOR SLABS AND FOOTINGS, AND 3,500 P.S.I. FOR DRIVEWAYS, EXTERIOR AND GARAGE SLABS.
- 9. ALL INTERIOR ROOM FINISHES INCLUDING WALL AND CEILING COVERINGS FOR ROOMS OR ENCLOSED SPACES SHALL HAVE A FLAME SPREAD RATING OF 200 OR LESS.
- 10. ALL HEATING, VENTILATING AND AIR CONDITIONING AND/OR ALL APPLICABLE LOCAL CODES AND ORDINANCES AND SHALL CONFORM TO STANDARD TRADE PRACTICES. REQUIRED BUILDING PERMITS SHALL BE OBTAINED AND PAID FOR BY THE RESPECTIVE TRADES.
- 11. TO AVOID FRAMING CONFLICTS, VERIFY ALL HVAC REQUIREMENTS 7. CONCRETE PROTECTION FOR REINFORCING AS WELL AS PLACING AND PRIOR TO FRAMING.
- 12. COORDINATE THE LOCATION OF ALL PLUMBING PIPING WITH THE MECHANICAL AND ELECTRICAL EQUIPMENT.
- 13. ELECTRICAL AND PLUMBING SHALL BE ROUGHED-IN BEFORE THE FRAMING INSPECTION IS MADE.
- 14. ALL POTABLE WATER OUTLETS SHALL BE PROTECTED FROM CROSS CONNECTIONS.
- 15. ALL SMOKE ALARMS SHALL BE LISTED IN ACCORDANCE WITH UL 217 AND INSTALLED IN ACCORDANCE WITH THE PROVISIONS OF THIS CODE AND THE HOUSEHOLD FIRE WARNING EQUIPMENT PROVISIONS OF THE NEPA 72. PER SECTION R314 SMOKE ALARMS SHALL BE INSTALLED IN THE FOLLOWING LOCATIONS: ONE IN EACH SLEEPING AREA, IMMEDIATELY OUTSIDE OF SLEEPING AREA, AND ON EACH STORY OF DWELLING INCLUDING BASEMENTS. DWELLINGS HAVING MORE THAN ONE SMOKE ALARM SHALL BE ACTIVATE ALL OF THE ALARMS IN THE INDIVIDUAL DWELLING PER

  12. PIER FOOTING THICKNESS SHALL BE ONE—HALF (MINIMUM) INTERCONNECTED SO THAT THE ACTUATION OF ONE ALARM WILL SECTION R313.2. ALL SMOKE ALARMS SHALL NOT BE INSTALLED LESS THAN 20 FEET HORIZONTALLY FROM A PERMANTLY INSTALLED COOKING APPLIANCE
- 16. ALL GLAZING NINE (9) SQ. FT. OR LARGER, WITHIN 18" OF A FLOOR, WITHIN 24" OF A DOOR, IN WALLS ENCLOSING A STAIRWAY LANDING OR WITHIN 60" OF THE TOP AND BOTTOM OF STAIRWAYS WHERE THE BOTTOM EDGE OF THE GLASS IS LESS THAN 60" OF THE WALKING SURFACE, AND ANY GLAZING WITHIN 60" OF A BATHING TUB, SHALL BE SAFETY GLASS.
- 17. CONTRACTOR MUST VERIFY THAT SELECTED WINDOW UNITS FOR BEDROOMS MEET EGRESS MINIMUMS FOR WIDTH AND OPENING SIZE. UNIT SIZES SHOWN ON PLANS MAY NOT MEET EGRESS FOR ALL WINDOW MANUFACTURERS.
- 18. PROVIDE MINIMUM CLEAR HEADROOM OF 6'-8" AT EVERY STAIR NOSING
- 19. PROVIDE A SOLID/20 MIN. FIRE RATED DOOR BETWEEN THE GARAGE AND THE RESIDENCE. THE GARAGE SHALL BE SEPARATED FROM THE RESIDENCE AND ITS ATTIC AREA BY NOT LESS THAN 1/2" GYPSUM BOARD. WHERE THE SEPARATION IS A FLOOR/ CEILING ASSEMBLY, THE STRUCTURE SUPPORTING THE SEPARATION SHALL ALSO BE PROTECTED BY NOT LESS THAN 1/2" GYPSUM BOARD OR EQUIVALENT. PER SECTION R-302.5.1 I.R.C. .2015
- 20. PROVIDE EXHAUST FANS, VENTED DIRECTLY TO THE OUTSIDE, IN BATHROOMS, WATER CLOSET COMPARTMENTS, AND OTHER SIMILAR ROOMS WITHOUT THE MINIMUM REQUIRED OPERABLE WINDOWS.
- 21. CONTINUOUS WOOD STRUCTURAL PANEL SHEATHING SHALL BE INSTALLED IN ACCORDANCE WITH METHOD 3 OF SECTION R-602.10.3. FOR BRACED WALLS & IN ACCORDANCE WITH SECTION R-602.10.5 & TABLE R-602.10.5 OF THE I.R.C. .2015
- 22. TERMITE TREATMENT AT PERIMETER FOUNDATIONS (TYP.)
- 23. ALL REQUIRED EMERGENCY EGRESS WINDOWS ARE TO COMPLY W/ SECTION 310.1.1 OF THE I.R.C. 2015. THESE WINDOW UNITS ARE TO MEET OR EXCEED THE FOLLOWING DIMENSIONS: CLEAR OPENABLE AREA OF 5.7 SQ.FT. (5.0 SQ.FT. FOR GRADE LEVEL WINDOW UNITS), CLEAR OPENABLE WIDTH OF 20", CLEAR OPENABLE HEIGHT OF 24", AND HAVE A SILL HEIGHT OF NOT MORE THAN 44" ABOVE THE
- 24. ALL T.J.I. TRUSS PROVIDED AND DESIGNED BY SUPPLIER TO SUPPORT ACTUAL LOADS
- 25. WINDOW NOMENCLATURE SHOWN ON THESE PLANS IS FOR ANDERSEN 400 SERIES; SUBSTITUTE WINDOWS MAY BE USED IN LIEU OF UNITS SPECIFIED PROVIDING THEY MEET EGRESS AND HAVE A GLASS U-FACTOR EQUAL OR LESS THAN .35
- 26. THE ELECTRICAL INSTALLATION SHALL CONFORM TO PART 8 OF THE INTERNATIONAL RESIDENTIAL CODE, 2015 AND NATIONAL ELECTRICAL CODE, 2011. A PERMIT SHALL BE SECURED PRIOR TO COMMENCEMENT OF ANY WORK.
- **27.** ARTICLE 210-8 OF THE 2011 NATIONAL ELECTRICAL CODE REQUIRES A DEDICATED 20 AMP. CIRCUIT FOR BATHROOM RECEPTACLES THAT IS PROTECTED WITH A GROUND FAULT CIRCUIT INTERRUPTER (GFCI) ALL KITCHEN COUNTER RECEPTACLES SHALL ALSO BE PROTECTED WITH
- 28. ALL WOOD/LUMBER TO BE SOUTHERN PINE #2 UNLESS OTHERWISE NOTED.

- 29. IRC SECTION R602.8 AND R302.11.1 FIRE/DRAFT STOPPING DETAILS: FIREBLOCKING SHALL BE PROVED TO CUT OFF ALL CONCEALED DRAFT OPENINGS (BOTH VERTICAL AND HORIZONTAL) AND FORM AN EFFECTIVE FIRE BARRIER BETWEEN STORIES, AND BETWEEN A TOP STORY AND ROOF SPACE. FIREBLOCKING SHALL BE PROVED IN WOOD-FRAME CONSTRUCTION 1. IN CONCEALED SPACES OF STUD WALLS. 1.1 VERTICALLY AT CEILING AND FLOOR LEVELS. 1.2 HORIZONTALLY AT INTERVALS, NOT EXCEEDING 10 FEET. 2. AT ALL INTERCONNECTIONS BETWEEN CONCEALED VERTICAL AND HORIZONTAL SPACES. 3. IN SPACES BETWEEN STAIR STRINGERS AT TOP AND BOTTOM OF THE RUN. 4. AT OPENINGS AROUND VENTS, PIPES, AND DUCTS AT CEILINGS AND FLOOR LEVELS, WITH AN APPROVED MATERIAL TO RESIST THE PASSAGE OF FLAME AND PRODUCTS OF COMBUSTION. 5. FIREBLOCKING OF CORNICES OF A TWO FAMILY DWELLING AT THE LINE OF THE DWELLING UNIT SEPARATION. DRAFT STOPPING IS REQUIRED AS PER R302.12 IN FLOORS WHEN OPEN WEB
- **30.** IRC SECTION R317.3.3 PRESSURE TREATED WOOD FASTENER: FASTENERS FOR THE PRESSURE TREATED PRESERVATIVE AND FIRE RETARDANT—TREATED WOOD SHALL BE HOT-DIPPED GALVANIZED STEEL, STAINLESS STEEL, SILICON BRONZE OR COPPER. EXCEPTION: ONE-HALF INCH DIAMETER OR GREATER STEEL BOLTS. SEE TABLE 602.3(3) FOR SHEATHING AND NAILING CODE REQUIREMENTS.
- 32. MIN. BEARING, TO BE 1 1/2" ON WOOD, 3" ON MASONRY OR METAL
- 33. THE TOTAL NET FREE VENTILATING AREA SHALL BE 1/300 OF THE TOTAL AREA, BASED UPON PROVIDING AT LEAST 50% OF THE TOTAL VENTS (UP TO A MAXIMUM OF 80% OF THE TOTAL VENTS) LOCATED IN THE UPPER PORTION OF THE SPACE TO BE VENTILATED (AT LEAST 3 FEET ABOVE THE EAVE VENTS, WITH THE BALANCE OF THE REQ'D VENTILATION PROVIDED BY FAVE VENTS. A TABLE OF PRODUCT OPTIONS IS PROVIDED BY SELECTION BY THE CONTRACTOR.
- 34. ALL DUCTS, AIR HANDLERS, FILTER BOXES AND BUILDING CAVITIES USED AS DUCTS SHALL BE SEALED. JOINTS AND SEAMS SHALL COMPLY WITH SECTION M1601.4.1 OF THE IRC CODE, 2015 EDITION.

# 35. STEEL BRICK LENTILS AS REQUIRED

## FOUNDATION NOTES

- 1. PRIOR TO CONSTRUCTION, ALL ORGANIC MATERIAL, TOP SOIL AND DEBRIS SHALL BE REMOVED FROM THE BUILDING AREA.
- 2. ALL FOOTINGS. INCLUDING SLAB ON GRADE. SHALL BEAR ON UN-DISTURBED SOIL OR COMPACTED STRUCTURAL FILL WITH AN ALLOWABLE BEARING CAPACITY OF 1,500 PSF.
- 3. ALL FOUNDATION CONCRETE FOR FOOTINGS AND INTERIOR SLABS SHALL OBTAIN A 28 DAY COMPRESSIVE STRENGTH OF 3,000 PSI.
- 4. BOTTOM OF ALL FOOTINGS SHALL BE A MINIMUM 12" BELOW FINISH
- GRADE OR AS PER LOCAL CODE REQUIREMENTS ELECTRICAL WORK SHALL BE PERFORMED IN ACCORDANCE WITH 5. EARTH FORMED FOOTINGS SHALL CONFORM TO THE SHAPE, LINES AND DIMENSIONS AS SHOWN ON THE FOUNDATION PLAN. ALL WATER SHALL

BE REMOVED PRIOR TO PLACING CONCRETE.

- 6. ALL REINFORCING STEEL SHALL BE IN ACCORDANCE WITH ASTM A615,
- FABRICATION OF REINFORCING SHALL BE IN ACCORDANCE WITH THE "AMERICAN CONCRETE INSTITUTE BUILDING CODE REQUIREMENTS"
- 8. ALL CONTINUOUS REINFORCING SHALL LAP 36 BAR DIAMETERS UNLESS OTHERWISE NOTED ON THE DRAWINGS.
- 9. BEFORE POURING CONCRETE ALL EMBEDDED ITEMS SHALL BE PROPERLY LOCATED, ACCURATELY POSITIONED, MAINTAINED SECURELY IN
- 10. NO BACKFILL SHALL BE DONE AGAINST MASONRY OR CONCRETE WALLS UNLESS ALL SLABS ARE POURED AND/OR WALLS ARE SECURELY
- 11. ANY STRUCTURAL BACKFILL REQUIRED, IN ADDITION TO THE MIN. THICKNESS AS SHOWN ON THE DRAWINGS, SHALL BE PLACED IN 8 TO 10 INCH LOOSE LAYERS AND BE COMPACTED TO A MINIMUM OF 95% OF MAXIMUM DRY DENSITY AS DETERMINED BY THE STANDARD PROCTOR TEST ( A.S.T.M. D-698 ).
- THE WIDTH OF THE FOOTING.
- 13. HOLLOW PIERS SHALL BE CAPPED WITH 4 INCHES OF SOLID
- 14. PROVIDE WALL TIES, FLASHING, AND WEEP HOL AT FLOOR LINE FOR BRICK FOUNDATION WALLS

1. THESE PLANS AUTHORIZE A SINGLE-USE LICENSE TO COI HOUSE. UNAUTHORIZED USE OF THE PLANS, MORE THAN ONE TIME, IS A COPYRIGHT VIOLATION SUBJECT TO PROSECUTION BY FEDERAL LAWS TO THE FULLEST EXTENT PROVIDED. RESALE OF TH TO A THIRD PARTY, ANYONE OTHER THAN THE ORIGINAL PUR OF THE SINGLE-USE LICENSE, CONSTITUTES COPYRIGHT INFRINGEMENT AND IS STRICTLY PROHIBITED.

WOOD HEADER & GIRDER SCHEDULE AS PER TABLE R502.5(1) AND R502.5(2)													
	WIDTH	EXTERIOR BEARING WALLS						INTERIOR BEARING WALLS					
WOOD HEADER SIZE	BUILDING WID	ROC CEIL		ROOF, & ONE BEARIN	CENTER	ROOF, & ONE FLOO	CLEAR	ROOF, & TWO BEARING	CENTER	ONE FI ON	_OORS LY	TWO FI	_OORS LY
		SPAN°	NJ⁵	SPAN*	NJ⁵	SPAN°	NJ⁵	SPAN*	NJ⁵	SPAN°	NJ⁵	SPAN*	NJ®
	20'	4-0	1	3-6	1	2-11	1	2-8	1	4-1	1	2-7	1
2-2x4	28'	3–1	1	2-6	1	2-3	1	2-1	1	2–10	1	1-11	1
	36'	2-7	1	2-2	1	1-10	1	1-9	1	2-4	1	1-7	1
	20'	6-0	1	4-10	1	4-4	1	4-0	1	6-1	1	3–11	1
2-2x6	28'	4–7	1	3–9	1	3–7	2	3-2	2	4-4	1	2-11	2
	36'	3–10	1	3–3	2	2-10	2	2-8	2	3-6	1	2-5	2
	20'	7–7	1	6-1	1	5-6	2	5-0	2	7–9	1	5-0	1
2-2x8	28'	5-9	1	4-10	2	4–3	2	4-0	2	5-5	1	3–8	2
	36'	4–10	2	4-1	2	3–7	2	3–5	2	4-5	2	3–1	2
	20'	9-5	1	7–8	1	6-11	1	6-4	1	9-8	1	6–3	1
3–2x8	28'	7–3	1	6-0	1	5–3	2	5-0	2	6–10	1	4–7	2
	36'	6–1	1	5–1	2	4-11	2	4–3	2	6-3	1	3–10	2
	20'	9-0	1	7–3	2	6-7	2	6-0	2	9-2	1	5-11	2
2-2x10	28'	6-10	2	5-8	2	5-0	2	4-9	2	6-6	2	4-4	2
	36'	5-9	2	4-10	2	4-2	2	4-0	2	5-3	2	3-7	2
	20'	11-3	1	9-1	1	8-3	2	7-6	2	11-5	1	7–5	1
3–2x10	28'	8-7	1	7-2	2	6-3	2	5-11	2	8–1	1	5-6	2
	36'	7–3	2	6-1	2	5-3	2	5-1	2	6-7	2	4-6	2
0 0.40	20' 28'	10-7	2	8-6	2	7–9	2	7-0	2	10-9	1	6-11	2
2-2x12		8-1	2	6-8		5-11		5-7	2	7–7	2	5-2	
	<i>36</i> ° <i>20</i> °	6-10 13-2	2	5-8 10-8	2	4-11 9-8	<u>3</u>	4-9 8-10	<u>3</u>	6-3 13-6	2	4-3 8-8	<u>3</u>
3-2x12	20°	10-1	2	8-5	2	9-0 7-5	2	7-0	2	13-6 9-6	2	6-5	2
J-2X12	36°	8-6	2	7-2	2	6-2	2	5–11	2	9-0 7-9	2	5-4	2

# THE MANCHESTER



BUILDING DESIGN LOADS						
	ROOF DEAD LOAD	20 p.s.f.				
	ROOF LIVE LOAD	20 p.s.f.				
	ATTICS (W/ LIMITED STORAGE) LIVE LOAD	20 p.s.f.				
	DECK LIVE LOAD	40 p.s.f.				
	ROOMS (OTHER THAN SLEEPING) LIVE LOAD	40 p.s.f.				
	SLEEPING ROOMS LIVE LOAD	30 p.s.f.				
	STAIR LIVE LOAD	40 p.s.f.				
	GROUND SNOW LOAD	10 p.s.f.				
	SLAB ON GRADE	100 p.s.f.				
	WIND LOAD	100 p.s.f.				
	WIND EXPOSURE	В				
	SEISMIC DESIGN CATEGORY	Α				

	LIST OF SHEETS
A-O	COVER
A-1	FOUNDATION & FLOOR PLANS
A-2	ELEVATIONS & DETAILS
A-3	SECTION DETAILS
A-4	LIGHTING PLAN & INTERIOR ELEVATIONS

# BUILDING CLASSIFICATION USE GROUP: R-5 (RESIDENTIAL)

TYPE CONSTRUCTION: 5-B

CODE & EDITION EMPLOYED: THE VIRGINIA UNIFORM STATEWIDE BUILDING CODE (2015), BASED UPON THE INTERNATIONAL RESIDENTIAL CODE


BUILDING AF	REA	
FIRST FLOOR SECOND FLOOR	933.00 933.00	
TOTAL LIVING AREA	1,866.00	S.F.
ENTRY PORCH & BALCONY	196.00	S.F.
TOTAL BUILDING AREA	2,062.00	S.F.



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DATE	<i>REVISIONS</i>

COVER SHEET DATE: MAY 4, 2021 SCALE: As Noted DRAWN : B.M.A. CHECKED BY:



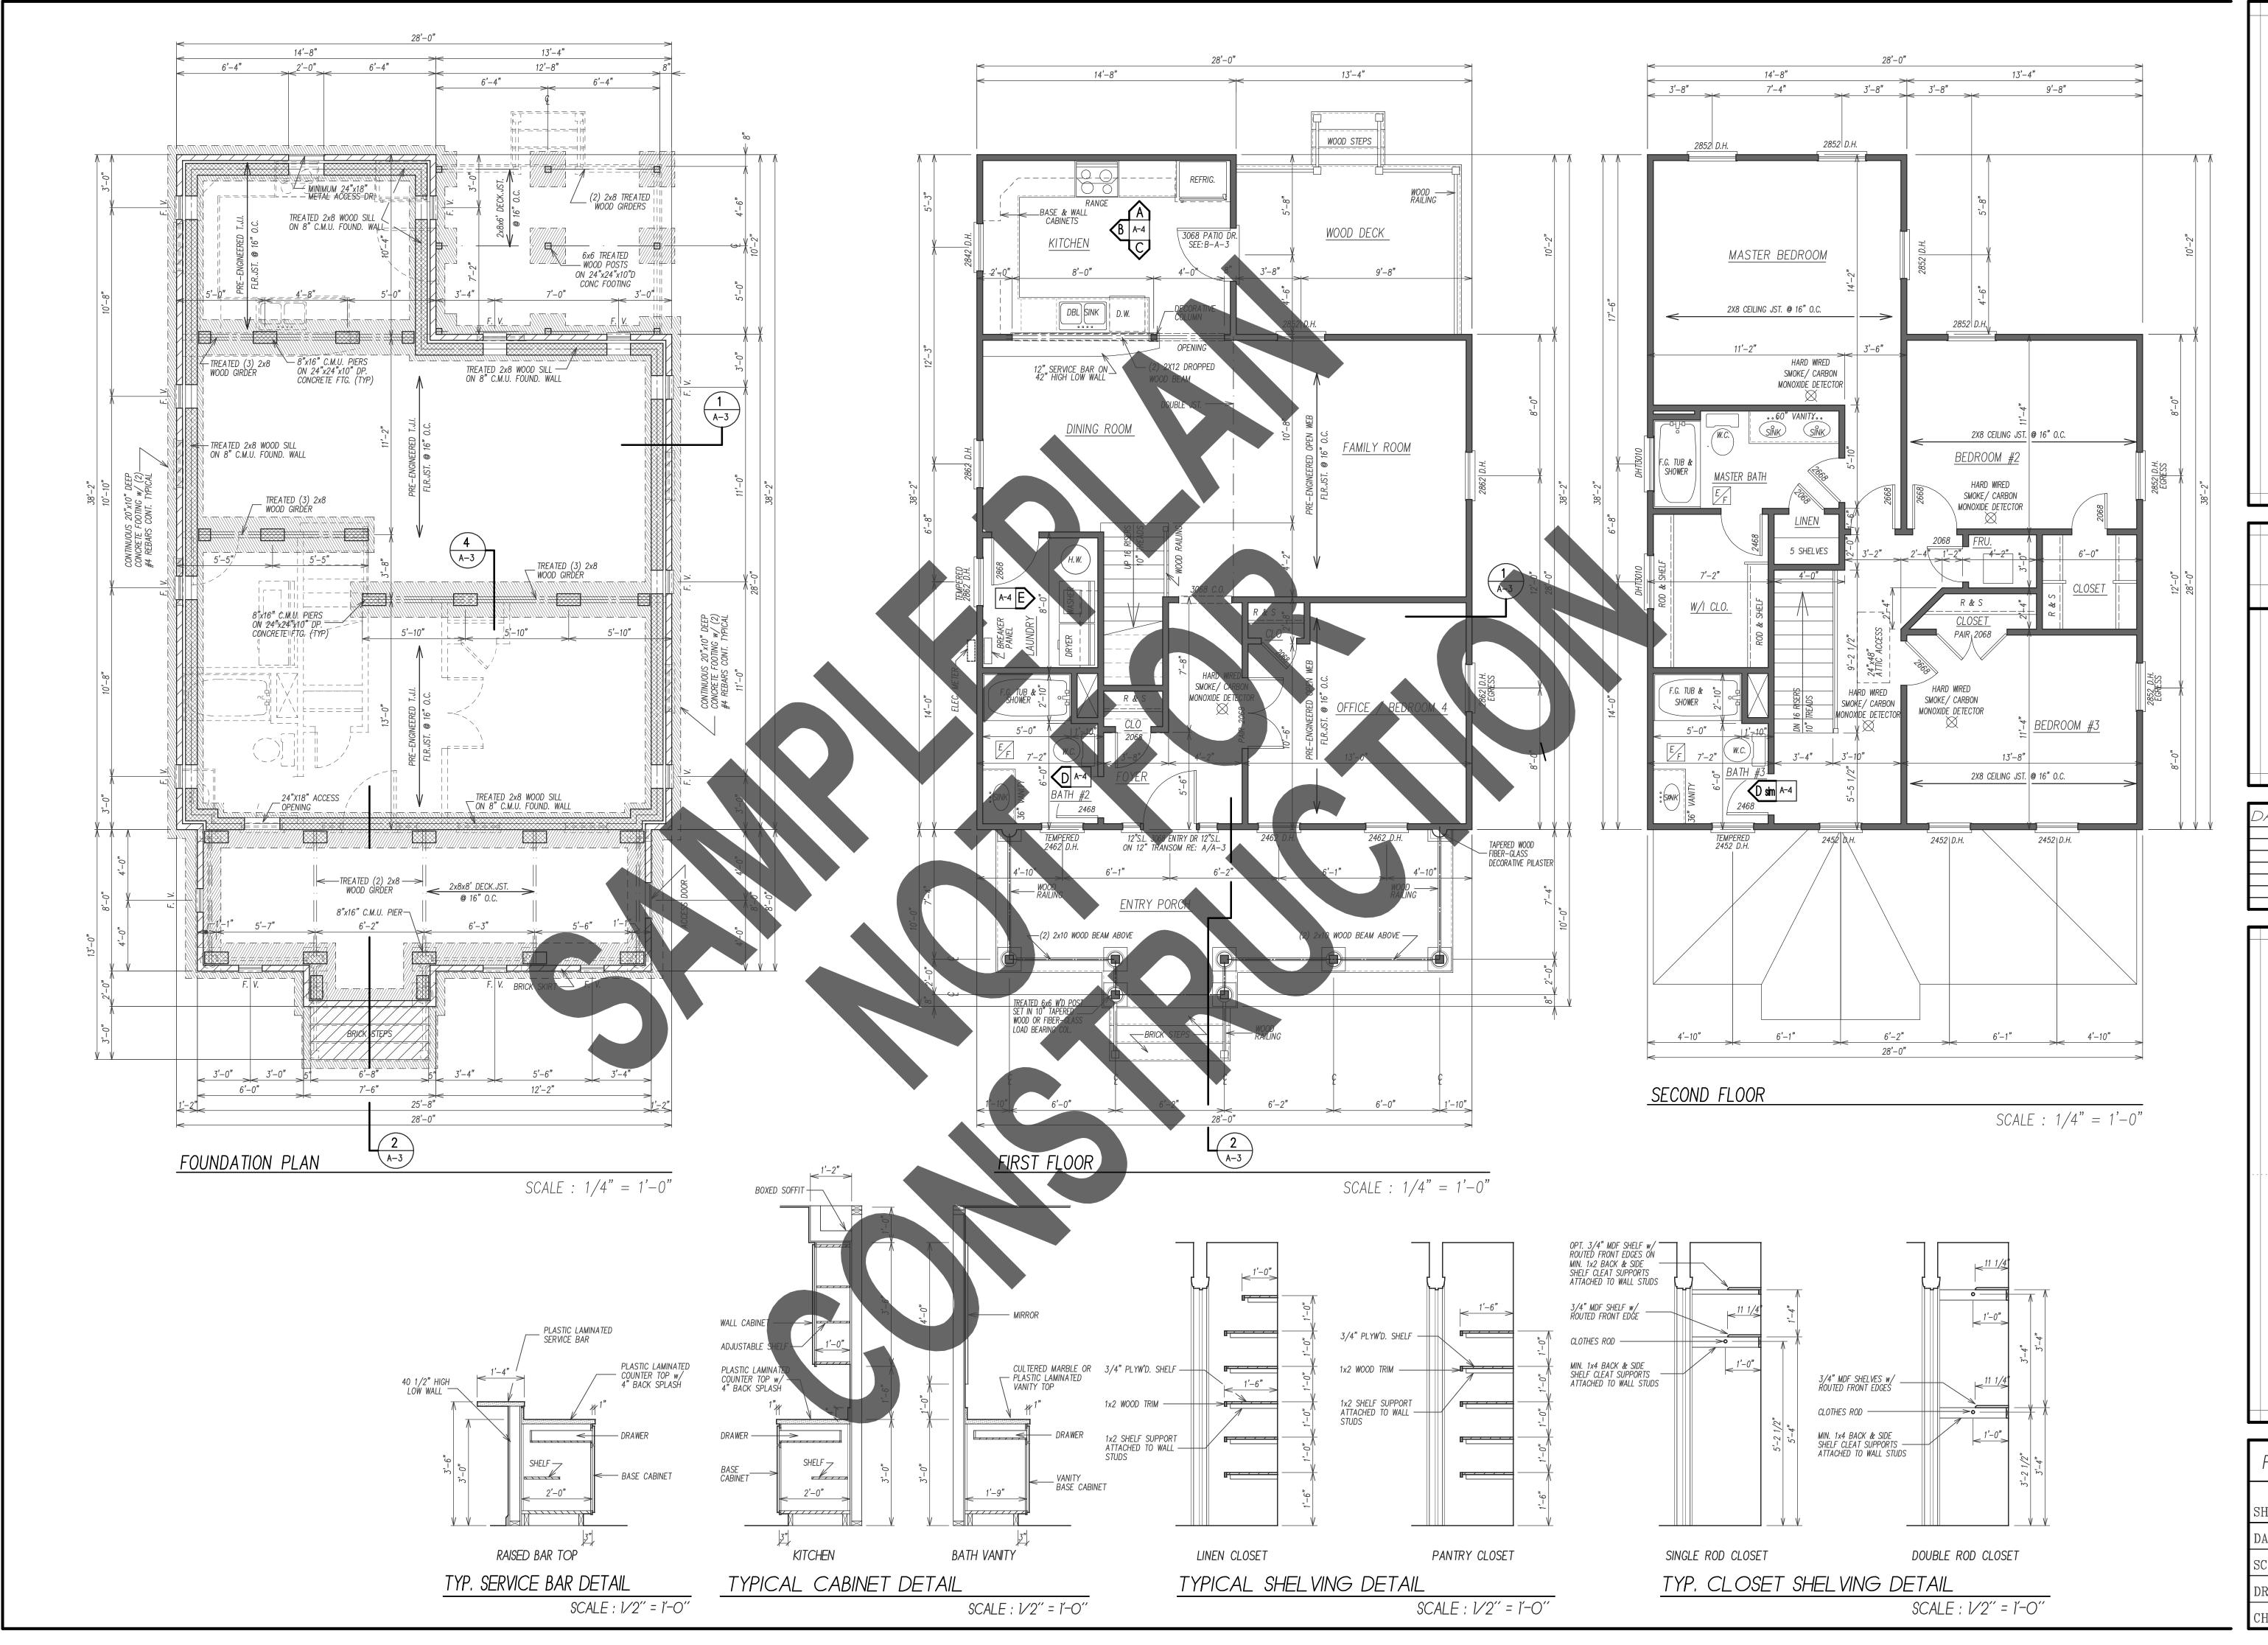

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FOUND. & FLOOR PLANS


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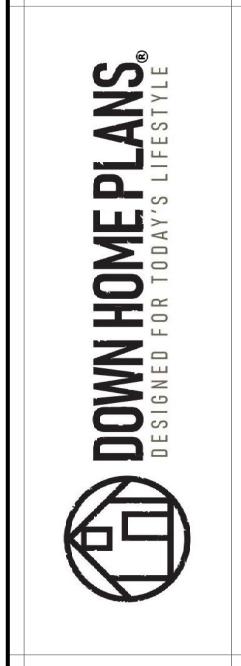
DATE: MAY 4, 2021

SCALE: As Noted

DRAWN: B.M.A.

CHECKED BY:



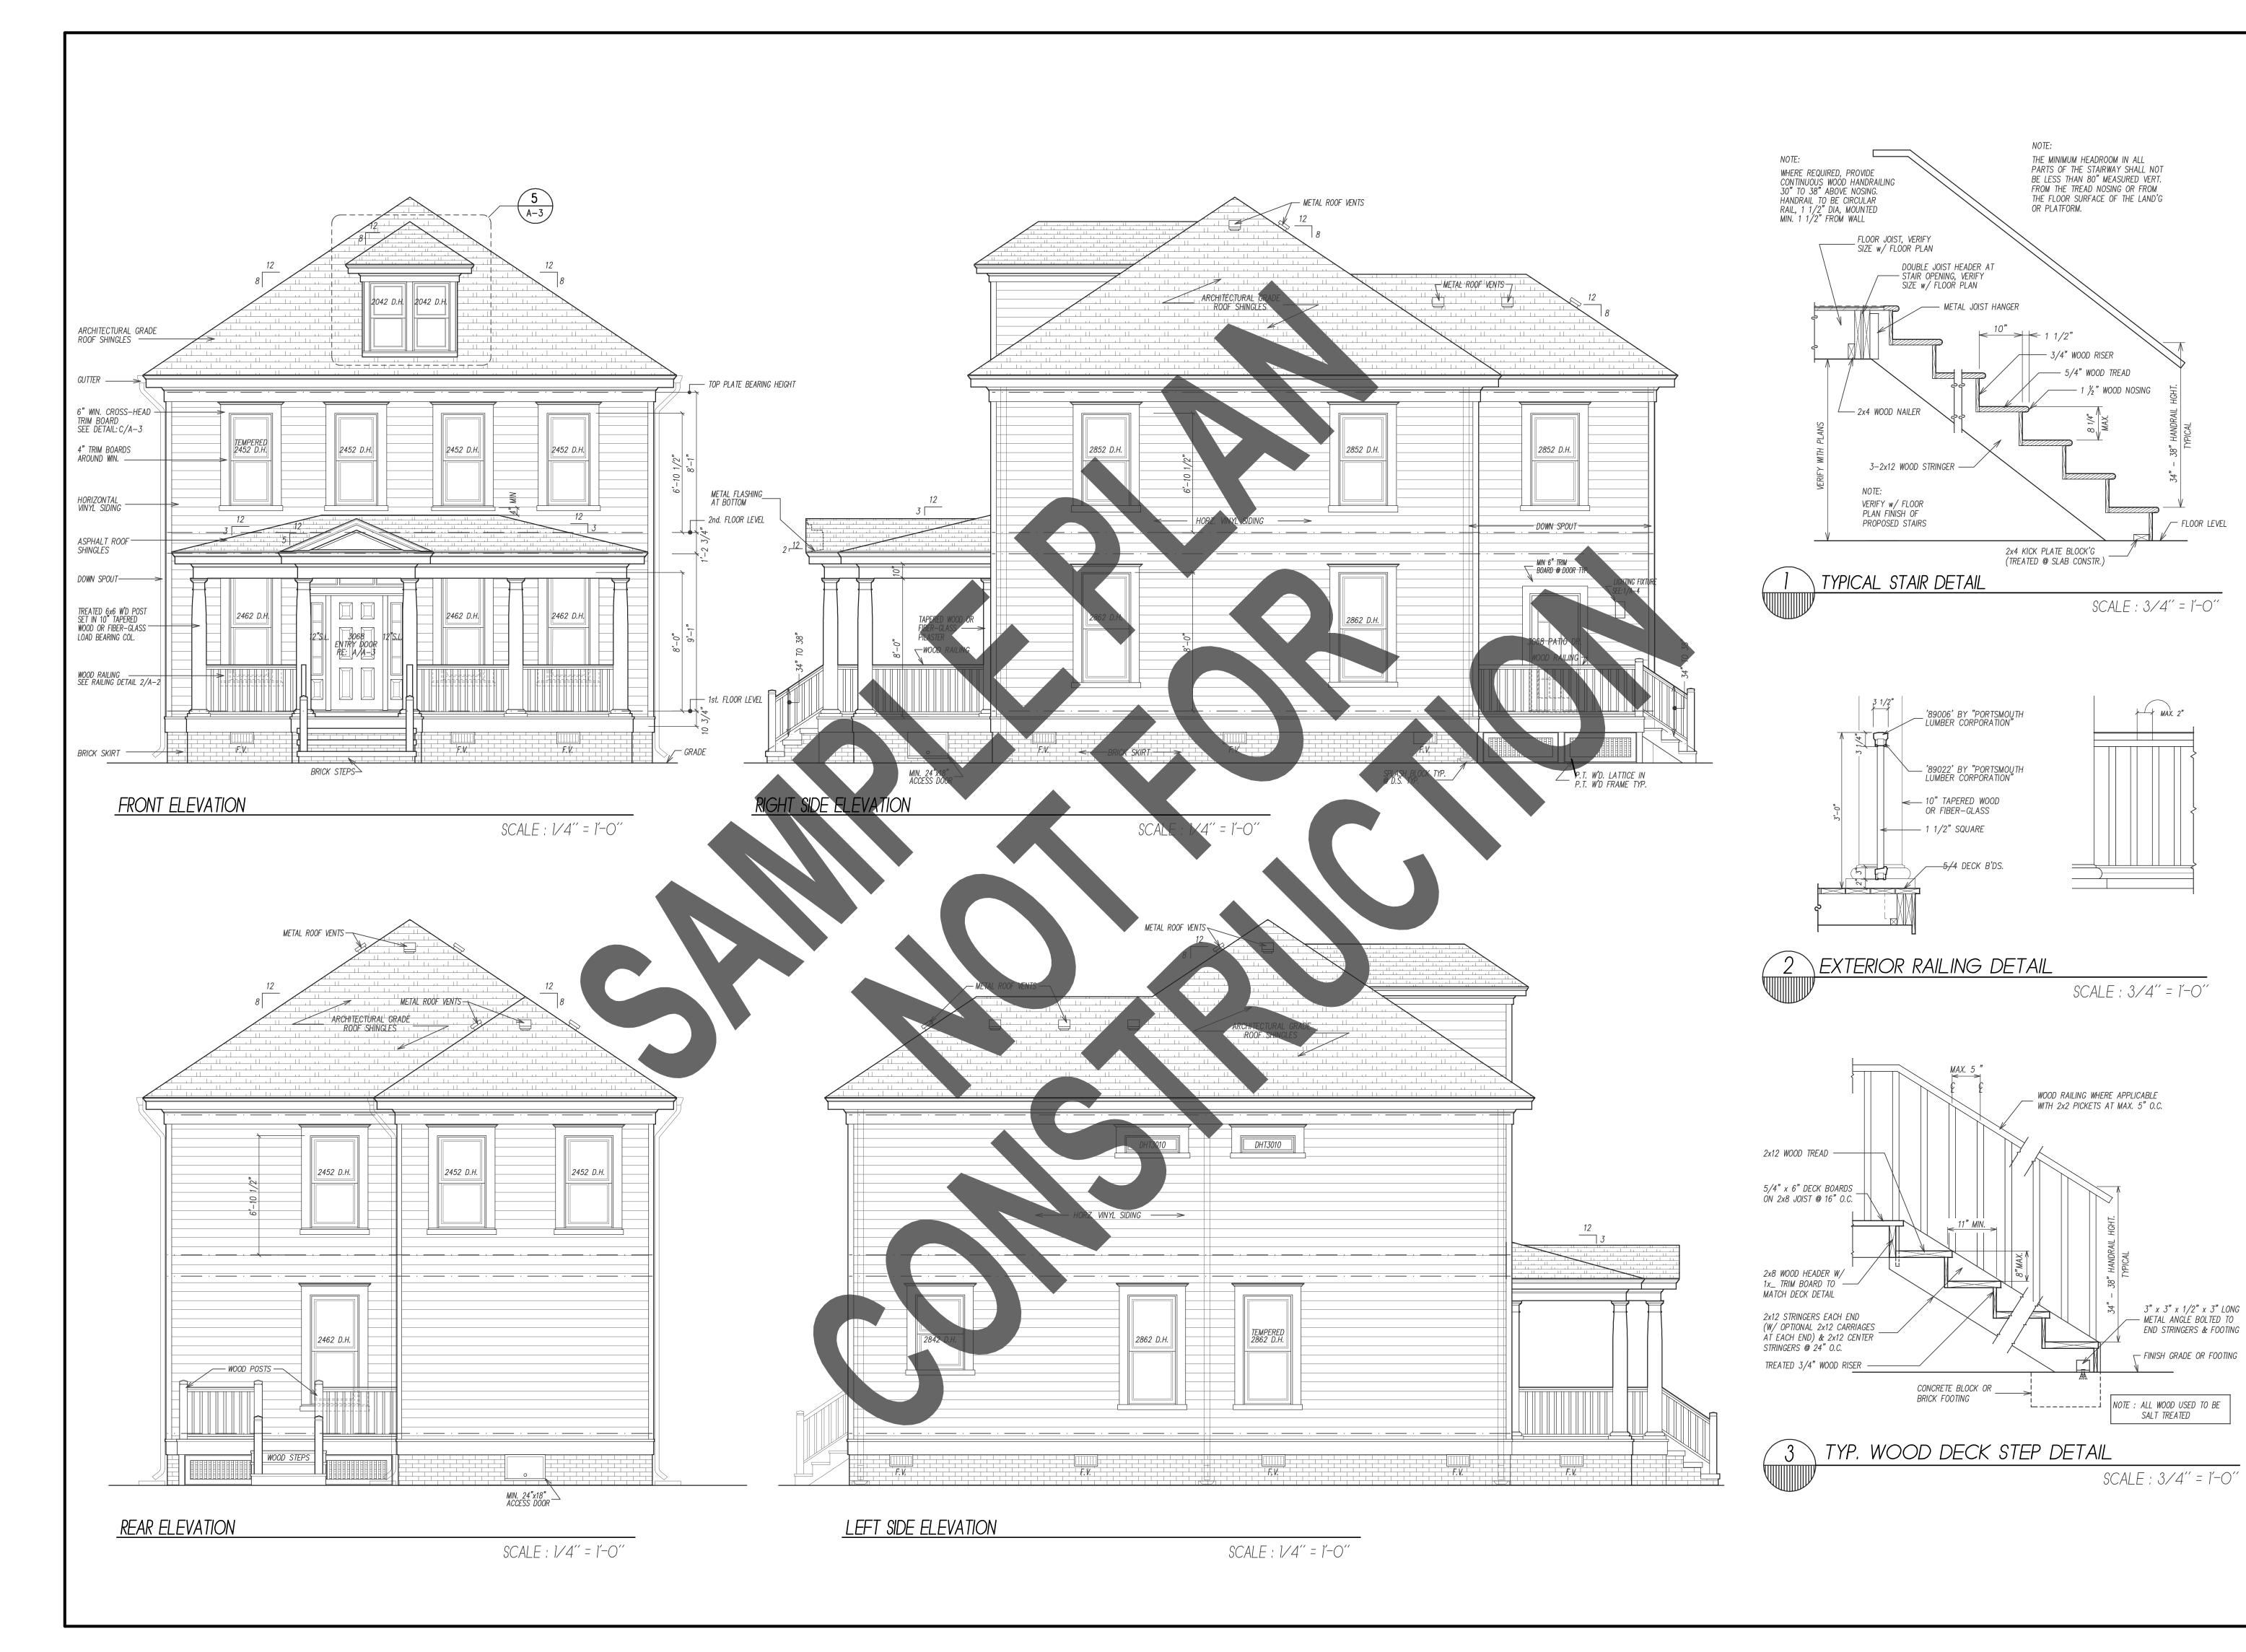

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SHEET: A - 2 of 4

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